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# Fitzsimons Doyle & Associates



An Bord Pleanála 64 Marlborough St, Rotunda, Dublin 1, D01 V902

Date: 3rd October 2022

AN BORD PLEANALA	ef: 22/5297 —
0 5 OCT 2022 Fee: € 50 Type: Time: By: POST	<u>re</u>

RE: DART+ West Project and Peter Joseph and Eimer Fallon Lands in the townland of Ballycurraghan Maynooth Co Kildare

Dear Sirs,

We act for Peter J Fallon and Eimer Fallon, owners of land adjacent to the proposed extension of the Irish Rail Network at their lands adjoining the Fallon's land.

On their behalf we wish to lodge an observation and objection to the granting of planning permission for the DART+ West Railway application. We enclose herewith the statutory fee of €50.00.

#### Location

For the purposes of clarification of the above we are enclosing the site location maps of DART+ West numbers 37-41.

We are also enclosing the Land Registry Map for Folio KE613365F (C54KE) for the Fallon's land and a site location map.

#### History and Development of Fallon's Land

In 2008, Peter Fallon bought the lands at Ballcurraghan Maynooth for the specific purpose of developing an equine centre for the rearing and treatment of thoroughbred horses. His daughter Eimer attended university and obtained a degree of Batchelor of Science in Equine Science. Since graduating Eimer went on to train with the most prestigious stud farms in Ireland and aboard including the United Kingdom, Saudi Arabia and the United Arab Emirates. Eimer is now recognized as an accomplished Equine Veterinarian Specialist and her services are much sought after. She is currently working in Saudi Arabia.







Stephen Hynes



From the out set it was Peter and Eimer Fallon's intention that she would set up an equine centre in Ballycurraghan and continue her career there until retirement.

In order to achieve this Peter Fallon has set about improving the lands at Ballycurraghan. Installing fencing and drainage, clearing and replanting of grass lands, commencement of construction of;

- (A) An American type barn comprising of 8 No Horse boxes, tack room and feed store
- (B) Erection of hayshed and covered dung shed and all associated site works
  The above works have received planning permission from Kildare County
  Council.
- (C) In addition, they have applied for planning permission for a new residence on the lands for Eimer Fallon Planning Ref No 082141 This was refused by Kildare County Council however following additional advice received from a planning consultant it is intended to re-apply for the planning permission for the replacement of the temporary residential unit on the site. This unit has been on site for many years and the planning consultants are confident that planning permission will be forthcoming.

From these matters shown above you can see that the lands at Ballycurraghan are intended for the home and employment of Eimer Fallon. Not only will the intended lands give employment to Eimer, it is intended that 3 to 4 other equine employment positions will be created by the Equine Centre.

#### Effects of DART+ West Depot on Ballycurraghan

The development of the DART+ West Rail System is an admirable and progressive project which Peter and Eimer Fallon have no objection to in principle. It is the fact that the siting of the 'Depot' or marshalling yard for the railway system is located right next to their lands.

No account has been taken by Irish Rail or their consultants to try to mitigate the effects of the location of the 'Depot' adjacent to the paddocks and fields used for equine purposes by the Fallons.

No consultation took place with the Fallons as to the use of their lands and the possible effects of

- (1) the 'Depot'
- (2) the addition of rail traffic
- (3) the new road traffic
- (4) the marshalling yard



#### **Environment**

The rearing and medical treatment of thoroughbred horses requires a quiet and tranquil environment.

The proximity of the 'Depot' to the Fallons land will give rise to

- (1) Noise
- (2) Flashing lights
- (3) Pollution and flooding
- (4) Security problems
- (5) Unpleasant environment for future residence
- (6) Problems of housing of horses and extra nursing and attention

#### 1 - Noise

The disturbance can be broken down into two categories:

- (1) Construction Noise
- (2) Operation Noise

#### **Construction Noise**

There are heavy civil engineering works required to complete the infrastructures of the 'Depot' as outlined in drawings No 37-41 and the Railway Order Book of Reference No 39-40 (copy enclosed).

There is the construction of the new bridge and road access of the R.148 existing road. The road access to the 'Depot' is located adjacent to the North East corner of Fallons Paddock as shown on drawing 'Works Layout Plan No WP39'.

The entrance roadway to the marshalling yard and the yard tracks are opposite the paddock. There will be considerate excavation works and the importation of ballast, tracks and overhead structures. The extract from the Book of References outlines a very large and industrialised construction which will create serious noise and disruption to the Equine Centre.

#### **Operational Noise**

The 'Depot' is an offset from the tracks of the main line. The choice of the location of the 'Depot' adjacent to the equine centre is unfortunate. The operation facility of the 'Depot' is directly opposite the Fallons Paddock Ref 39.8.

The permanent compound and storage material for the 'Depot' is also closely opposite the Fallons Paddock Ref 39.14 and 39.15.



Thus the noise of lighting, transporting and stacking of ballast, heavy steel beams and construction equipment and machinery will be a constant and indefinite operation thus causing noise and disruption to the Equine Centre.

#### Flashing Lights

The disruption and disturbance from flashing lights can be from two sources

- (1) Construction of 'Depot'
- (2) Operation of 'Depot'

#### Construction

The lights from construction equipment will cause flashes and constant illumination during twilight hours. In construction times the flashing lights will occur during commissioning.

Cars and construction equipment travelling over the bridge will have headlight beams directed at the paddocks.

Cars and construction equipment entering and exiting the 'Depot' will travel along the roadway adjacent to the paddocks with lights flashing.

#### Operation

The trains entering the 'Depot' will travel in an East to West/West to East direction entering and leaving the 'Depot'. Thus there will be over head operational lighting particularly at the control centre Ref 39.8 and 39.9.

The trains stopping and starting will give rise to flashes. This operation is directly opposite the North West corner of the Fallons Paddock.

#### Pollution and Flooding

The construction of the 'Depot' will give rise to pollution from rising dust, airborne dust and infiltration of the Water Systems and the natural drainage of the site and the adjoining lands. This can be broken down into two categories also

- (1) Construction
- (2) Operational



### **Construction Pollution and Flooding**

The construction of the 'Depot' adjacent to the Fallons Paddock will give rise to pollution of their lands and air from air bourne dust.

The location of the largest of four compounds directly opposite the Fallons Paddock will create the most intense pollution. The hauling in of the ballast for the marshalling yard and the spreading and compacting of hardcore for road works, tracks and buildings will cause serious air pollution. Construction works will also cause dust.

The stream which runs along the boundary of Fallon's North boundary is particularly vulnerable and horses will have to be prevented from using this stream for drinking water. Fresh water will have to be delivered to the paddocks on a regular basis during construction.

The wastewater from the construction site will have to be treated and it is not clear from the drawings how this will be achieved.

## **Operation Pollution and Flooding**

The operation of the 'Depot' with trains coming and going on a constant basis in a confined site will give rise to air bourne dust from ballast and the general environment of the 'Depot'. The size of the attenuation tank appears to be small and there does not seem to be sufficient volume provided for the run off of the industrial use of the 'Depot' compared to the existing normal run off of agricultural lands ie the capacity of the attenuation tank is too small.

#### Security

The opening up of the Northern boundary and exposing it to a public road raises the problem of security of the paddocks on Fallon's land.

The Northern boundary is not open to a public road where additional security will have to be provided by inserting a 2.4 meter fence along the boundary and for a distance south on each of the East and West boundaries.

Security cameras will be required to protect high value mares and fouls grazing in the paddocks.

#### **Unpleasant Environment for Future Residence**

It is intended to construct a substantial residence of approximately 250 m2 to the holding to house Eimer Fallon and her future family. The romantic aspect and residential enjoyment of the site will be destroyed by the construction of the 'Depot' and an environment of a heavy industrialised railway depot will be substituted for the open clear and unobtrusive views and aspect of the present country environment. This will greatly reduce the value and enjoyment of the holding.



Problems of housing of horses and extra nursing facilities

The reality of the construction and operation of the 'Depot' for the DART+ West railway system is that the locating of the 'Depot' adjacent to and directly opposite the Northern boundary of the Fallons land make it no longer viable for the operation of the equine centre.

The probability of horses bolting and stampeding from noise and light flashes poses a serious risk to animals of high value.

The intended customers for the Equine Centre will be discouraged from using it for fear of injury to their animals.

The provision of insurance for the operation will become an impossible task or if available will be an uneconomical cost.

The Fallons are asking the Bord to request Irish Rail to find an alternative location for the 'Depot'. If this cannot be achieved they will have no alternative but to seek compensation for the injurious effect caused to their lands and their business. They will suffer it's impending closure as a result of the future operation of the DART+ West System.


Yours sincerely,

John Doyle Far.Ing. C.Eng. MIEI F.Cons EI

**Chartered Engineer** 

# EXTRACT RELEVANT TO PETER & EMMER FAZLON



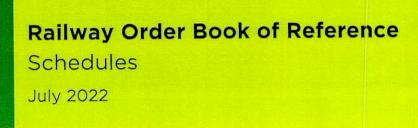



















# **List of Abbreviations**

Abbreviation	Meaning	
ASP	Auxiliary supply points for Low voltage	
CCE	Chief Civil Engineer	
CCTV	Closed Circuit Television	
CIÉ	Córas Iompair Éireann	
CME	Chief Mechanical Engineer	
CMS	Cable management system	
CWR	Continuous welded rail	
DART	Dublin Area Rapid Transport (IÉ's Electrified Network)	
DC	Direct current	
EIA	Environmental Impact Assessment	
EIAR	Environmental Impact Assessment Report	
EMU	Electric Multiple Unit	
ESB	Electricity Supply Board	
ESBN	ESB Network	
FLU	Full length unit	
GAA	Gaelic Athletic Association	
GDA	Great Dublin Area	
GSM	Global System for Mobile communications	
GSM-R	GSM – Railway	
GSWR	Great Southern & Western Railway	
HGV	Heavy goods vehicle	
HV	High voltage	
HVAC	Heating, Ventilation, Air conditioning	
ΙÉ	Iarnród Éireann/Irish Rail	
IR	Iarnród Éireann/Irish Rail	
IW	Irish Water	

Abbreviation	Meaning
MEP	Mechanical, Electrical, Plumbing
MSDC	Main Storage & Distribution Centre
MGWR	Midland Great Western Railway
NIAH	National Inventory of Architectural Heritage
NTA	National Transport Authority
NTCC	National Train Control Centre
occ	Operational Control Centre
OHLE	Overhead Line Equipment
OSD	Over station development
PPT	Phoenix Park Tunnel
PSP	Principal Supply points
RO	Railway Order
RRV	Rail road vehicle
RS	Rolling Stock
SCADA	Supervisory Control And Data Acquisition
SDZ	Strategic Development Zone
SEB	Signalling Equipment Buildings
SET	Signalling, Electrical, Telecommunication
SP	Security Purpose
SUDS	Sustainable urban drainage system
TER	Telecommunications Equipment Rooms
TII	Transport Infrastructure Ireland
TOR	Top of Rail
TPHPD	Trains Per Hour Per Direction
TSS	Train Service Specification





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Second Schedule - Part 3	Land upon which pole(s) may be erected
Second Schedule - Part 4	Airspace which maybe acquired
Third Schedule	Substratum land which may be acquired
Fourth Schedule	Land of which temporary possession may be taken
Fifth Schedule	Land over which Public Rights of Way or Other Easements may be acquired
Sixth Schedule	Public Rights, including Public Rights of Way which may be extinguished
Seventh Schedule	Private Rights, including Private Rights of Way which may be extinguished
Eighth Schedule	Public and Private Rights of Way which may be temporarily interrupted
Ninth Schedule	New roads including public roads and bridges which may be constructed
Tenth Schedule	Roads including public roads which may be altered, realigned or closed
Eleventh Schedule	Conditions imposed by An Bord Pleanála
Twelfth Schedule	Explanatory Notes in relation to the decision of An Bord Pleanála
Thirteenth Schedule	Agreements (including agreements with local authorities)

SCHEDULE 1
Railway works and works
authorised by this Order

RELEVANT TO FALLONS.

EXTRACT.

- Provision of twin track rail line between Maynooth Station and the proposed maintenance depot along with realignment of the rail line to the south of Jackson's Bridge
- Road realignment of the R148 regional road, west of Jackson's Bridge, a bridge over the canal and rail, new junctions and construction of new link roads to the depot and to the L5041 local road, south of Jackson's Bridge
- Provision of a new train maintenance depot between Maynooth and Kilcock
- Provision of excavated flood compensations areas between Maynooth and Kilcock
- Alteration of 220kV ESB line west of Maynooth
- Proposed temporary main storage & distribution centre off the R122 northwest of Dublin Airport

This Schedule 1 is intended to be read in conjunction with the Plan of the Railway Works - the referenced Railway Works Drawings (which includes Property Details Drawings, Alignment Details Drawings and Structural Details Drawings) which set out more particularly the railway works and which form part of this Railway Order.

# 39. Railway Order - Sheet 39 (29.0 - 30.0km)

Works No.	Description	Drawing No.
39.1	Realignment of R148 west of Jackson's Bridge south of the existing R148 with two roundabouts and a new bridge (OBG23A) over the rail and canal linking to realigned L5041 south of the rail line. Existing R148 to be broken up and removed, where no longer required. Provision of separate road access to the depot and connection to the existing road network (R148 and L5041) and new roundabouts north and south of the bridge.	
39.2	Demolition of an existing farm access bridge (OBG24) west of the proposed new bridge (OBG23A) including demolition of existing bridge over the canal and bridge over the greenway	• WP039
39.3	A new CCE (Chief Civil Engineering) Compound to the eastern side of the depot. The CCE Compound is to provide storage areas for ballast, and track elements such as sleepers, rails, space to stable maintenance vehicles, and accommodation and facilities for maintenance workers.  The CCE Compound building is in the southern part of the complex and adjacent to the	• WP039
	road entrance, provided with parking spaces on its western side. Dimensions of this building are 33m x 19m with a height of 5m.	
39.4	Construction of attenuation pond to manage runoff from depot and associated works.	• WP039
39.5	Provision of flood compensatory storage areas, to manage displaced flood waters and flood risk impacts on the existing drainage regime due to hydraulic constraints.	• WP039
39.6	Provision of a depot located on agricultural lands between Maynooth and Kilcock, parallel to the mainline with two railway connections to the mainline and road access from R148 over a length of approximately 2.5 km and up to 260m in width	• WP039
39.7	Provision of drainage systems two attenuation ponds to cater for treatment and attenuation of runoff from the depot and other proposed infrastructure.	• WP039

Works No.	Description	Drawing No.
39.8	Provision of an access control building close to the depot entrance gate to provide security control for the access/egress to the depot facilities.  Building dimensions (W x L x H): 5.0m x 5.0m x 3.0m.	• WP039
39.9	Provision of an electrical Traction Substation adjacent to the access control building. Fencing and provision of pedestrian and road access from the main road. Building dimensions (W x L x H): 10.0m x 30.0m x 5.0m.	• WP039
39.10	Internal access roads within depot	• WP039
39.11	Provision of a service slab enclosed building with open eastern and western facades to allow trains to pass to the facility. The southern margin of the building contains the staff amenities and the technical rooms and equipment. There is staff access to the building by the road and pedestrian paths to the south side of the building. Building dimensions (W x L x H): 23.7m x 184.0m x 9.0m	• WP039
39.12	Provision of an automatic washing plant AWP at the depot entrance, in the main access route for the trains which have passed through the AVI facility. The AWP dimensions are 42m long and 9.5m wide. The AWP has an adjacent control room for the control panel, equipment and tanks. Staff access to the building by the road and pedestrian paths to the facility's south side. The road has sufficient capacity at the eastern part to allow HGVs to manoeuvre when making deliveries within the AWP and the service slab area.	• WP039
39.13	Automatic Vehicle Inspection facility	• WP039
39.14	Prepare the sites and compounds initially by constructing safety fencing or hoarding as required, undertaking site clearance/demolition or diversion/protection works and excavating to formation level for all works.	• WP039
39.15	Establish construction sites and compounds at four locations including temporary fencing/hoarding, site offices, welfare facilities, storage facilities, workshops, construction plant and equipment required to carry out the works.	• WP039
39.16	Construct services and utility diversions and connections as shown indicatively on the drawings.	• WP039

Works No.	Description	Drawing No.
39.17	Provide traffic management measures in the vicinity of the construction sites, including temporary road closures, removal of parking spaces, redirection of traffic in the area and making good any damage to the roadway.	• WP039
39.18	Electrification of the existing rail line along with signalling and telecommunications infrastructure including installation of overhead electrification equipment.	• WP039
39.19	Installation of new fencing along rail boundary and temporary works areas for these works.	• WP039

# 40. Railway Order - Sheet 40 (30.0 – 31.0km)

Works No.	Description	Drawing No.
40.1	Provision of a main depot building in the southern part of the complex, parallel to the stabling yard, comprised of three main areas. i. The northern side for drivers and cleaners' facilities is proposed to be accessed by an underpass corridor from the main lobby of the building. ii. The central part of the building consists of the maintenance shed with all the maintenance tracks and train access from both sides of the building. iii. The southern part of the building with the workshops, storage, administration, and staff amenities.	• WP040
40.2	Provision of a carpark of 125 vehicles for staff and visitors in the main parking area close to the main building.	• WP040
40.3	Future provision for a second automatic washing facilities building and automatic vehicle inspections facilities building	• WP040
40.4	Provision of a space reserved for a recreational area with trees, landscaping, benches, and walking paths on the western side of the facility.	• WP040
40.5	Provision of unloading bay for train carriages, with an exterior yard of 34.0m x 110.0m for the manoeuvring of delivery vehicles.	• WP040
40.6	Provision of a stabling area parallel to the main building and the test track. The dimensions are 354m in length and 82.5m in width. The length of the stabling area is designed for berthing two <b>FLU</b> (Full Length <b>U</b> nits or 10-car units) with additional aprons at both sides of concrete slab track to allow the pass of vehicles. The stabling yard is composed of a ballast track and platforms for accessing the trains.	
40.7	Provision of an emergency access connecting to Branganstown Road/ Connaught Street.	• WP040
40.8	Provision of flood compensatory storage areas, to manage displaced flood waters and flood risk impacts on the existing drainage regime due to hydraulic constraints.	• WP040
40.9	Realignment of existing stream to the south of the depot	• WP040
40.10	Construct services and utility diversions and connections as shown indicatively on the drawings.	• WP040

Works No.	Description	Drawing No.
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# 41. Railway Order - Sheet 41 (31.0 – 32.0km)

Works No.	Description	Drawing No.
41.1	Provision of a single carriageway access road for emergency use to the depot with junction onto local Branganstown Road/ Connaught Street. Road lining and signage provided to indicate the presence/location of the new private junction for road users.	• WP041
41.2	Construction of railway platform and test track section	• WP041
41.3	Construction of a low-voltage principal supply point building and signalling equipment building near the proposed emergency access.	• WP041
41.4	Construct services and utility diversions and connections as shown indicatively on the drawings.	• WP041
41.5	Provide traffic management measures in the vicinity of the construction sites, including temporary road closures, removal of parking spaces, redirection of traffic in the area and making good any damage to the roadway.	• WP041
41.6	Installation of new fencing along rail boundary and temporary works areas for these works.	• WP041

# 42. Railway Order - Sheet 42 (MSDC 6.0- 7.0km, offset)

Works No.	Description The second	Drawing No.
42.1	A main storage and distribution centre (MSDC) is required to provide materials to the construction compounds that will be located along the line, reducing the required local storage space. The site is the Breffni Group property located off the R122 in the townland of Ballyhack, north of Corrstown Golf Club and approximately 6km north-west of Dublin Airport. The proposed compound will cover approximately 3.9HA of the existing site.	• WP042
42.2	The new surfacing to be constructed using gravel, concrete and blacktop (tarmac) surface materials. Some existing areas to be retained. A new proposed yard to be constructed using concrete surfacing.	• WP042
42.3	Landscaping works will comprise a combination of existing landscaped banks and newly planted areas.	• WP042
42.4	Access to the MSDC and surrounding properties from the R122 regional road will be maintained.	• WP042
42.5	A new proposed storage building will be constructed towards the east of the existing building.	• WP042
42.6	Existing attenuation storage ponds for overflow drainage will be retained.	• WP042
42.7	Temporary offices, workshops, hardstanding and sheds to be provided for the assembly, storage and management of materials and plant for the construction of the project	• WP042

# 40. Railway Order - Sheet 40 (30.0 - 31.0km)

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# Land Registry Sealed and Certified Copy Folio (& Filed Plan)

JOHN J. CROSS 11 AN CROIS ALLENWOOD NAAS CO. KILDARE

This page forms part of the official document. Do not detach.

Folio Number:

KE61336F

Application Number:

P2020LR061733T

Your Reference:

Ms Fallon

This document comprises an office copy of the Land Registry record for the above mentioned folio/filed plan as of the date appearing.

Details of **dealings pending** (if any) on the enclosed folio/filed plan are listed in the **Schedule** below.

An officer duly authorised by the Property Registration Authority.

#### Schedule

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#### Notes:

- 1. Filed plans should be read in conjunction with the Register. The description of the land in the Register or on the filed plan is not conclusive as to the boundaries or extent of the land (see Section 85 of the Registration of Title Act 1964, as substituted by Section 62 of the Registration of Deeds and Title Act, 2006).
- 2. Filed plans greater than A3 in size may be provided as separate A3 tiles with an overlap and print gutter. When aligning the tiled sheets, customers are advised to use the underlying topographical detail.
- 3. On receipt of this record, please check to verify that all the details contained therein are correct. If this is not the case, please return the document to the Property Registration Authority immediately.

Folio Number: KE61336F Date Printed: 24/08/2020 Application Number: P2020LR061733T Page 1 of 6

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# Land Registry

# County Kildare

Folio 61336F

#### Register of Ownership of Freehold Land

Part 1(A) - The Property

Note: Unless a note to the contrary appears, neither the description of land in the register nor its identification by reference to the Registry Map is conclusive as to boundaries or extent

No.	For parts transferred see Part 1(B) <b>Description</b>	Official Notes
1	The property shown coloured Red as plan(s) C54KE on the Registry Map, situate in the Townland of BALLYCURRAGHAN, in the Barony of SALT NORTH, in the Electoral Division of MAYNOOTH.	From Folio KE1120N
	The Registration does not extend to the mines and minerals	
	D2013LR036128G: The location of the seedpoint for Plan C54KE has been revised in accordance with Deed of Rectification dated 26th October 2012.	

Land Cert Issued: No

Page 1 of 4

Collection No.:

Date Printed: 24/08/2020

# Land Registry

County Kildare

Folio 61336F

# Part 1(B) - Property Parts Transferred

No.	Prop No:	Instrument:	Date:	Area (Hectares):	Plan:	Folio No:
						164

Page 2 of 4

Date Printed: 24/08/2020 Page 3 of 6

# Land Registry

County Kildare

Folio 61336F

## Part 2 - Ownership

#### Title ABSOLUTE

No.	The devo	lution o	f the	prope of th	erty is e Succes	subje sion	ct to th Act, 190	e provi 65	sions of	Par
1	24-NOV-2008 D2008KW021316E		FALLON	of 10	Airfield	Road,	Rathgar,	Dublin 6	is full	
									40	

Page 3 of 4

Date Printed: 24/08/2020 Page 4 of 6

# Land Registry

County Kildare


Folio 61336F

Part 3 - Burdens and Notices of Burdens

No.	Particulars

Page 4 of 4

Date Printed: 24/08/2020 Page 5 of 6

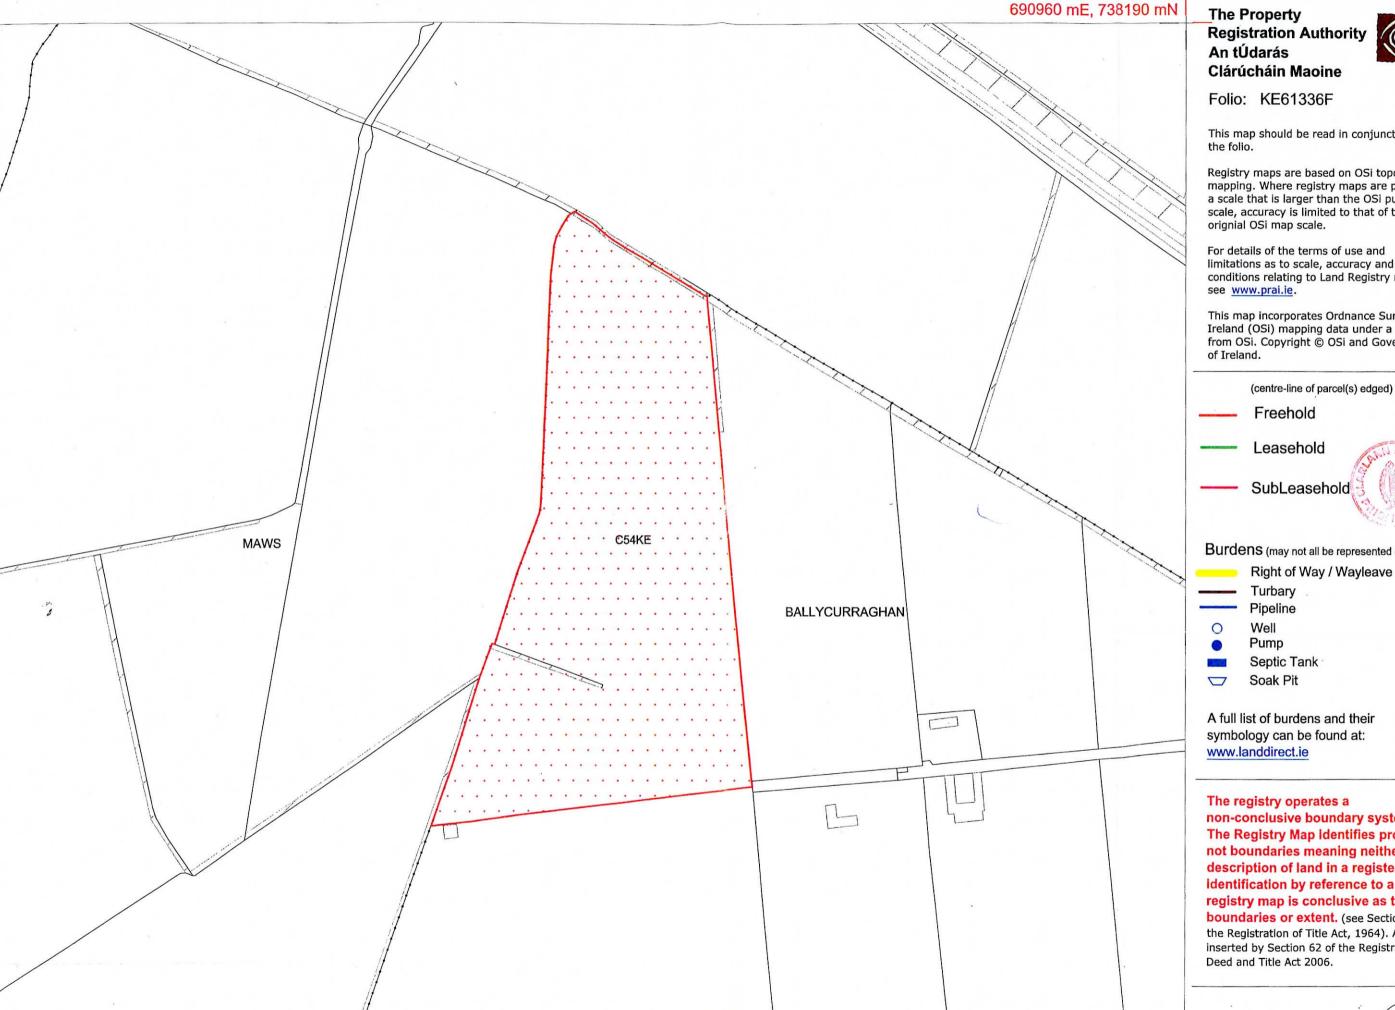

This map should be read in conjunction with

Registry maps are based on OSi topographic mapping. Where registry maps are printed at a scale that is larger than the OSi published scale, accuracy is limited to that of the

limitations as to scale, accuracy and other conditions relating to Land Registry maps,


This map incorporates Ordnance Survey Ireland (OSi) mapping data under a licence from OSi. Copyright © OSi and Government


(centre-line of parcel(s) edged)


Burdens (may not all be represented on map)


The registry operates a non-conclusive boundary system. The Registry Map Identifies properties not boundaries meaning neither the description of land in a register nor its identification by reference to a registry map is conclusive as to the boundaries or extent. (see Section 85 of the Registration of Title Act, 1964). As inserted by Section 62 of the Registration of


1:2500 Scale Page 6 of 6

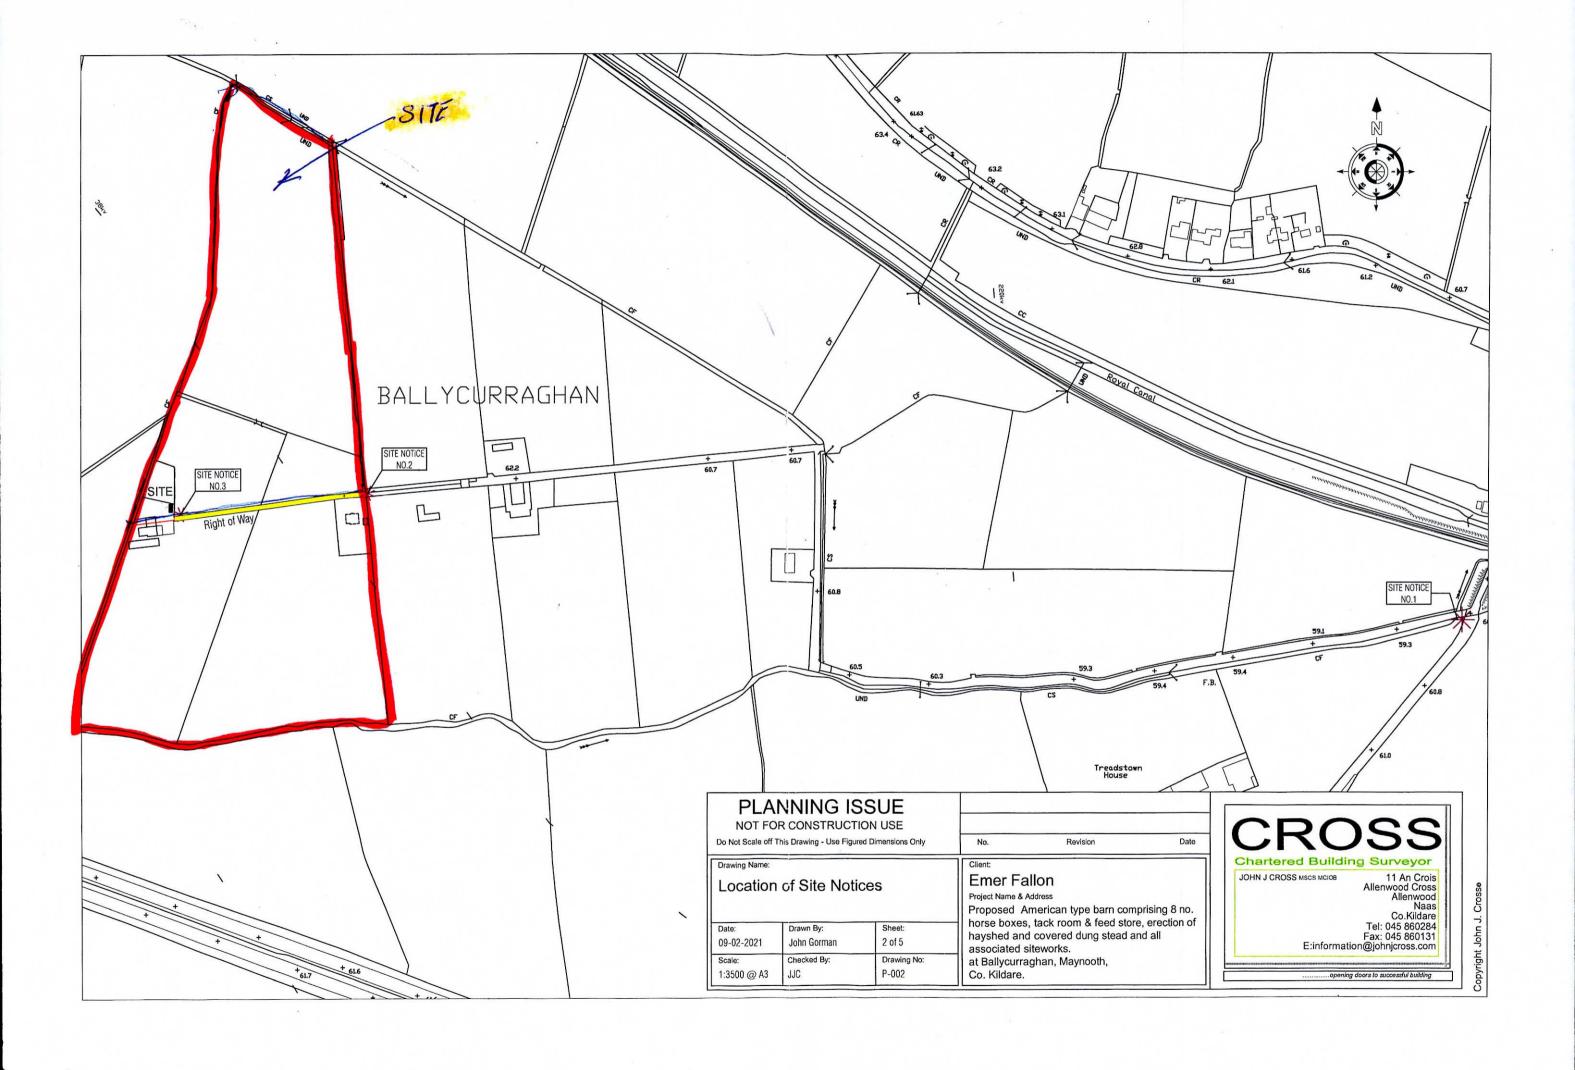


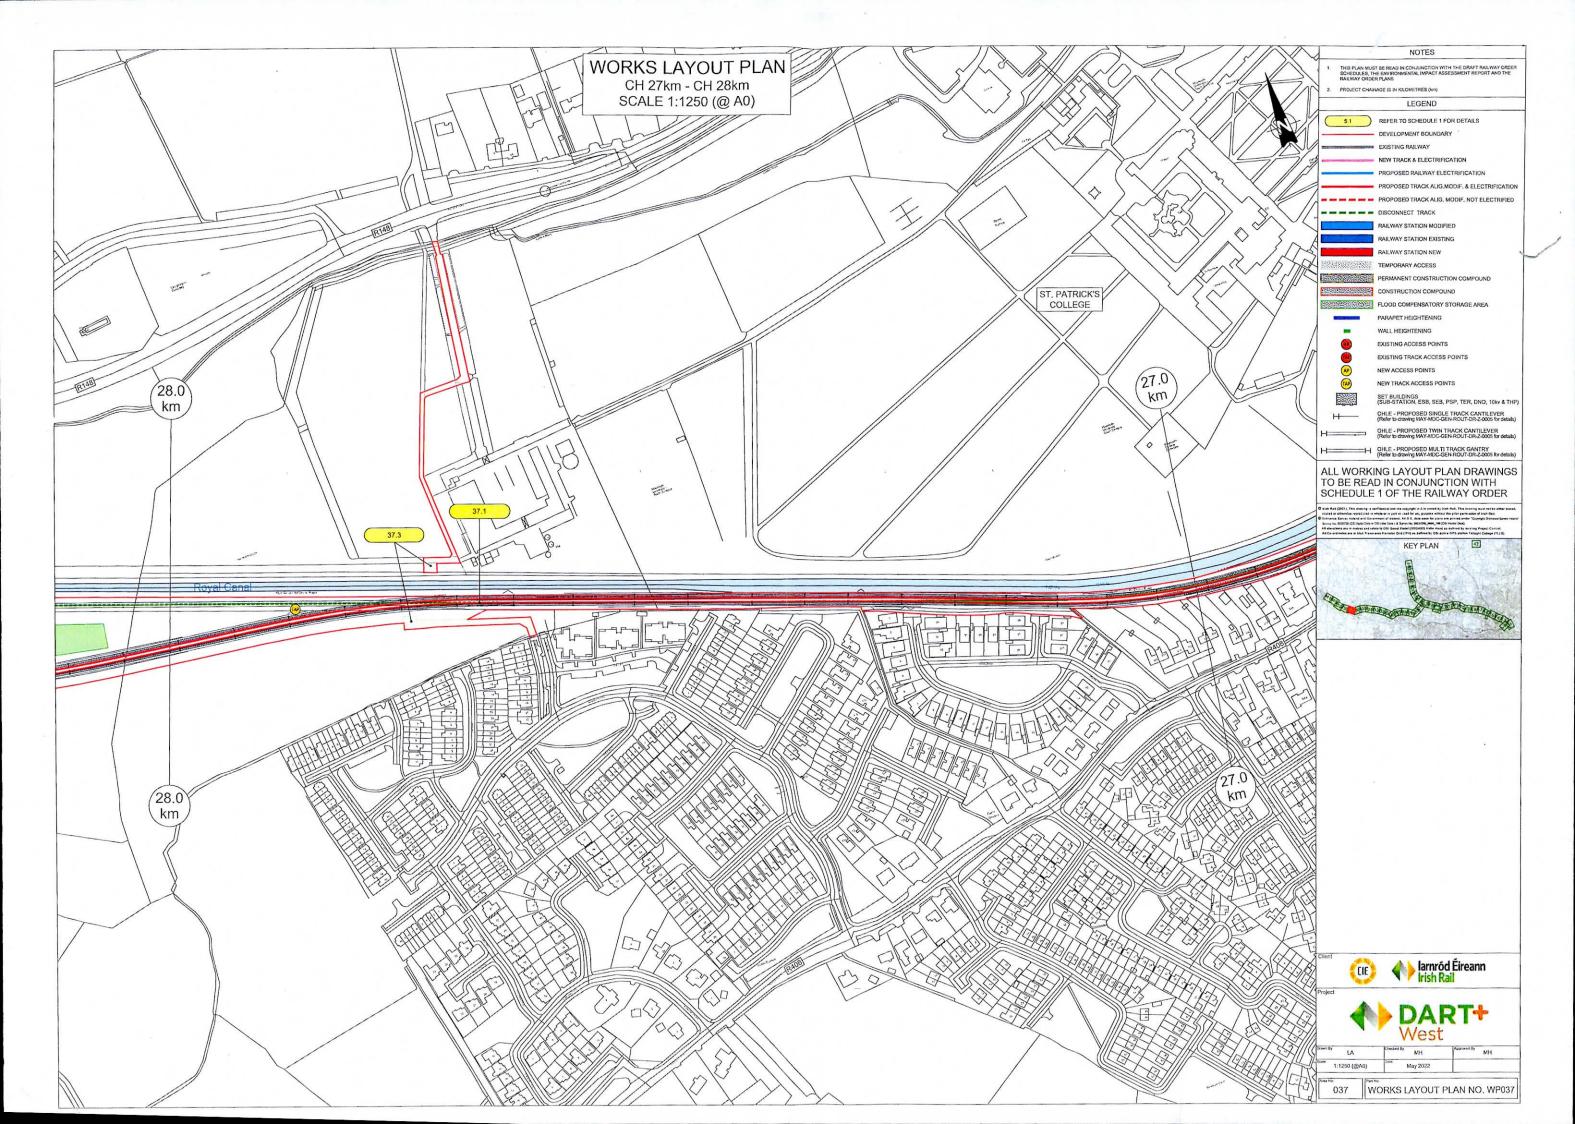


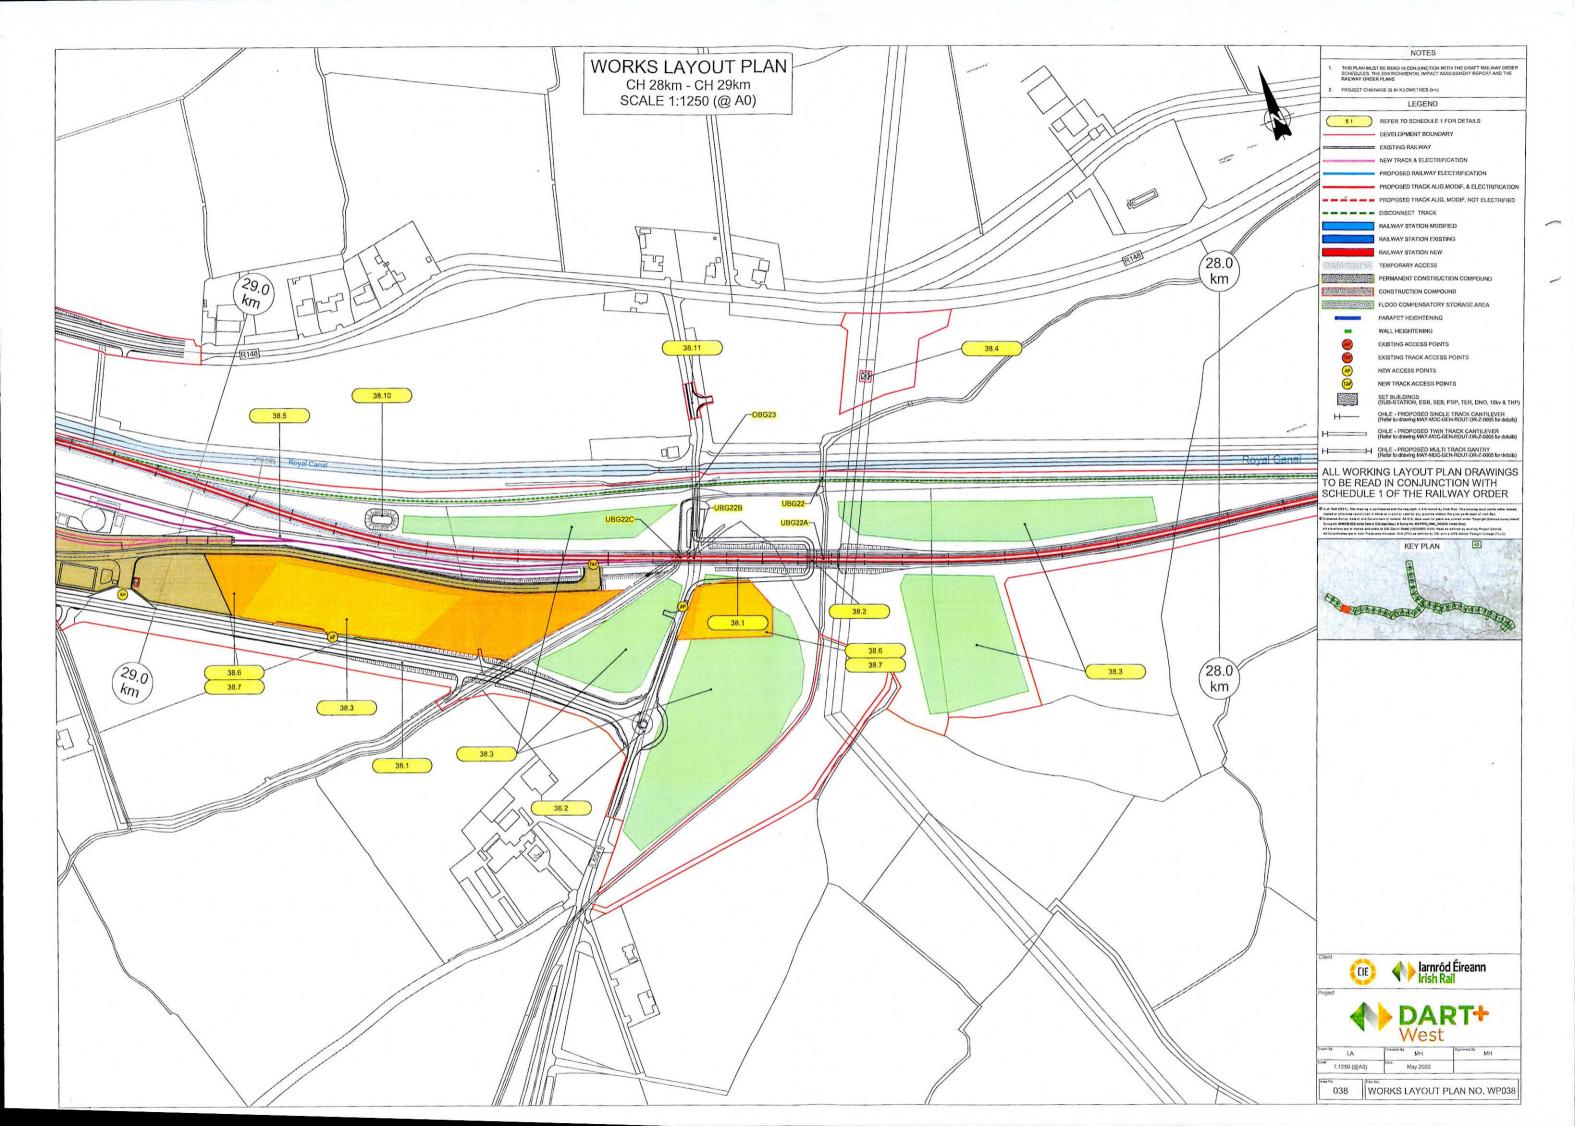


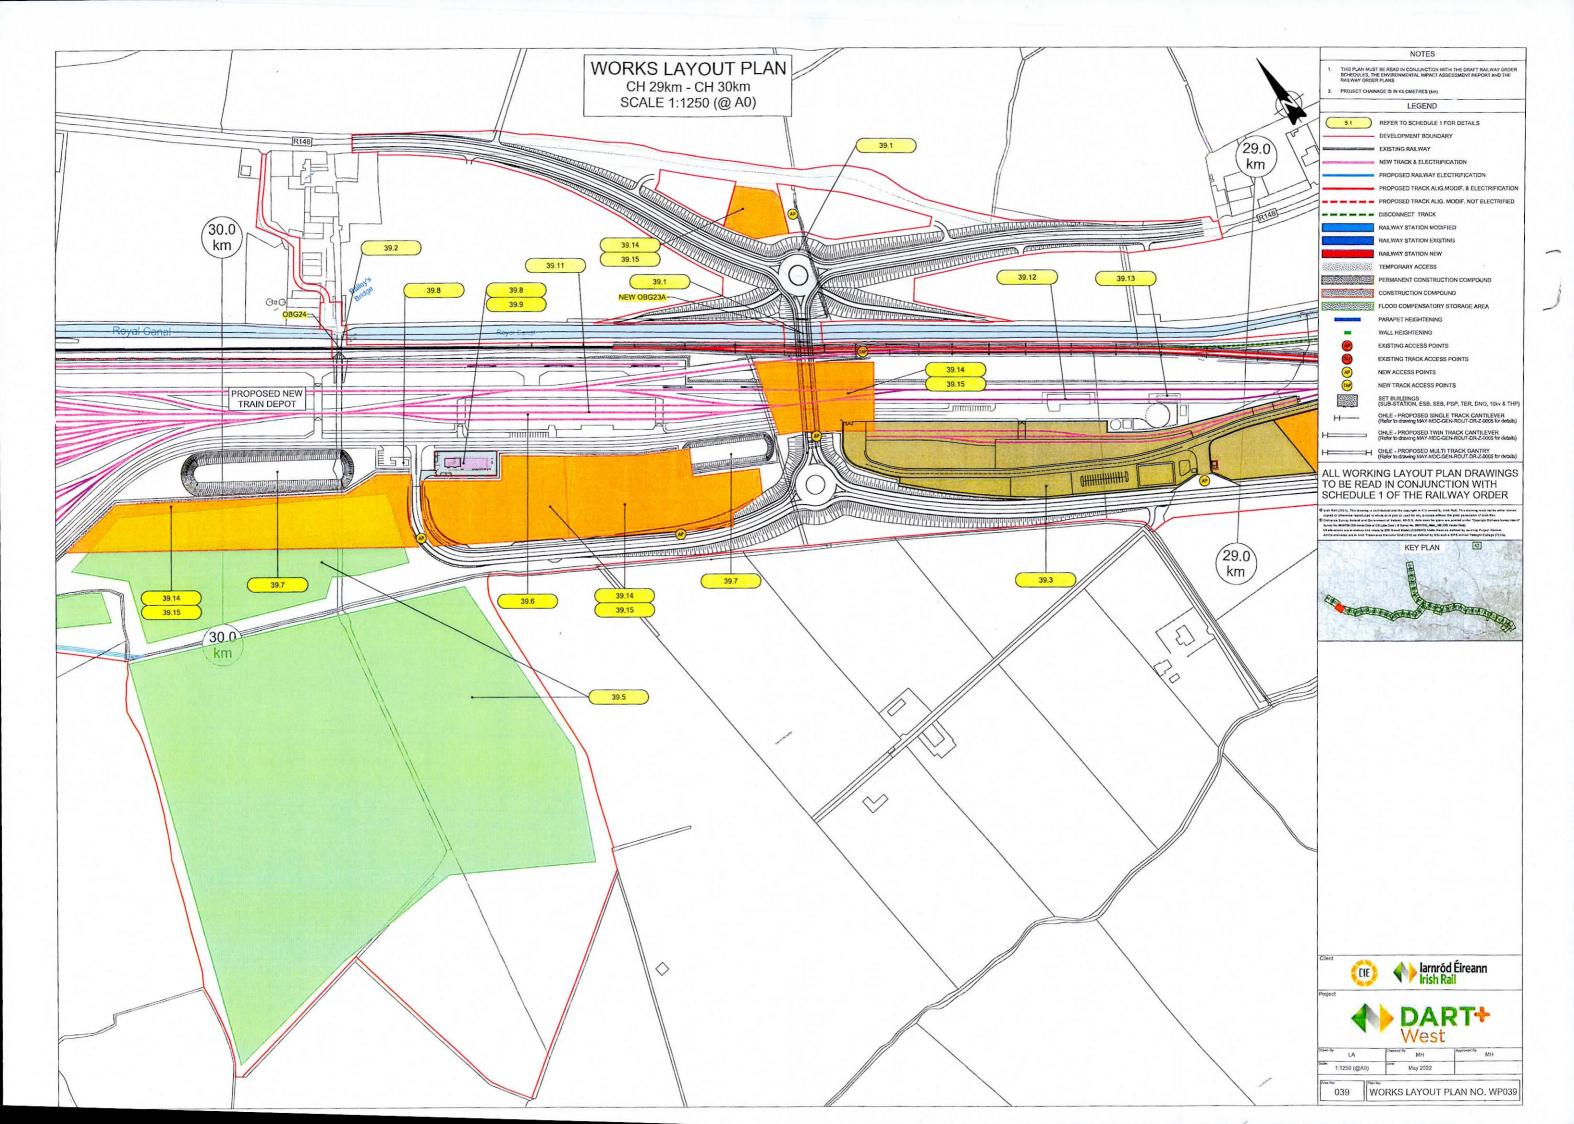

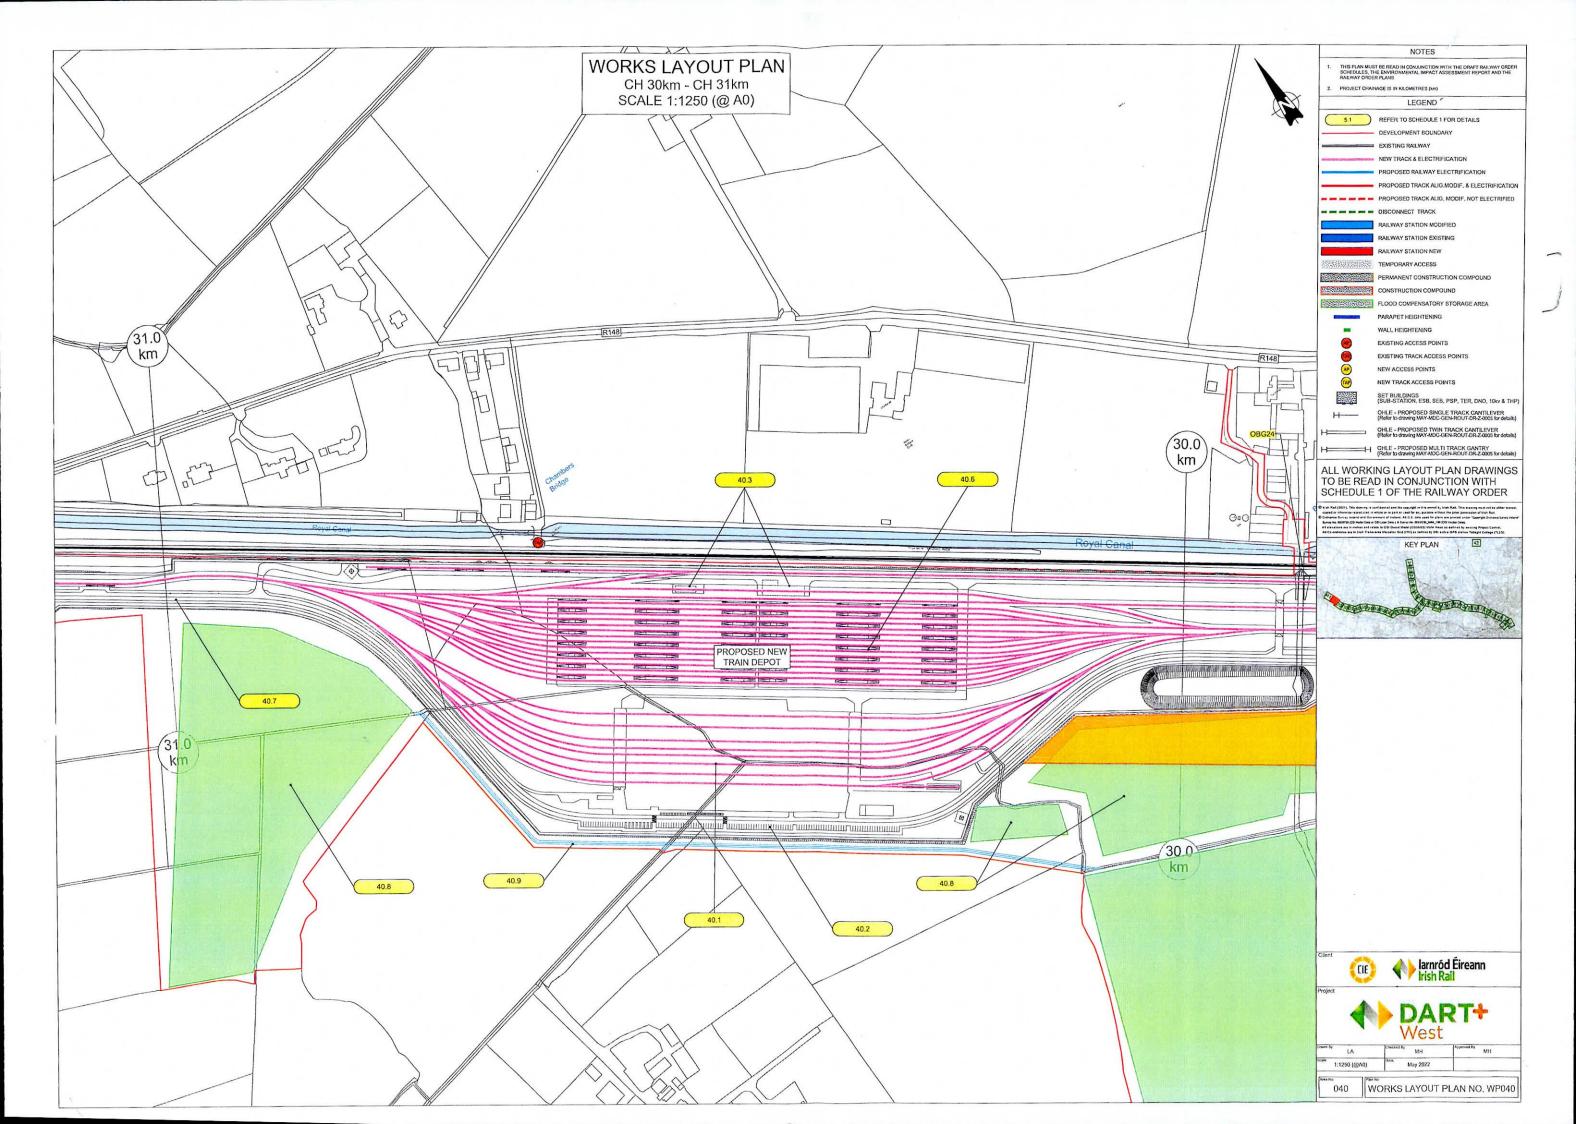

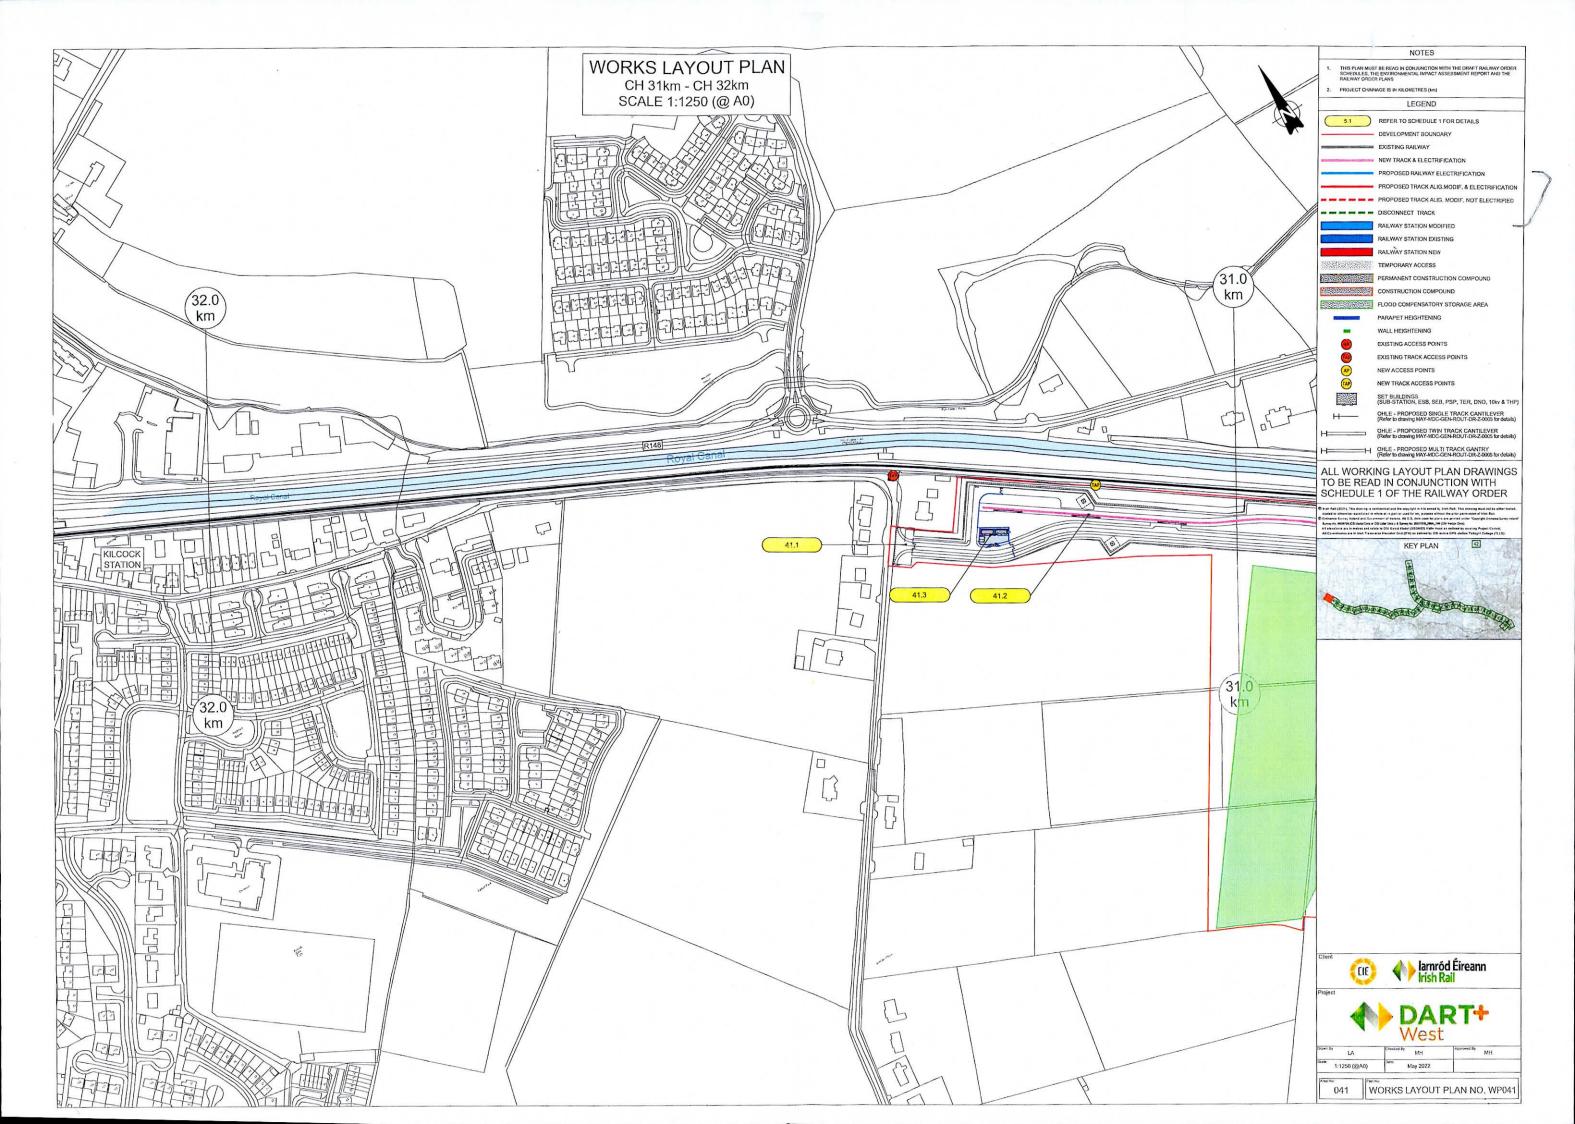


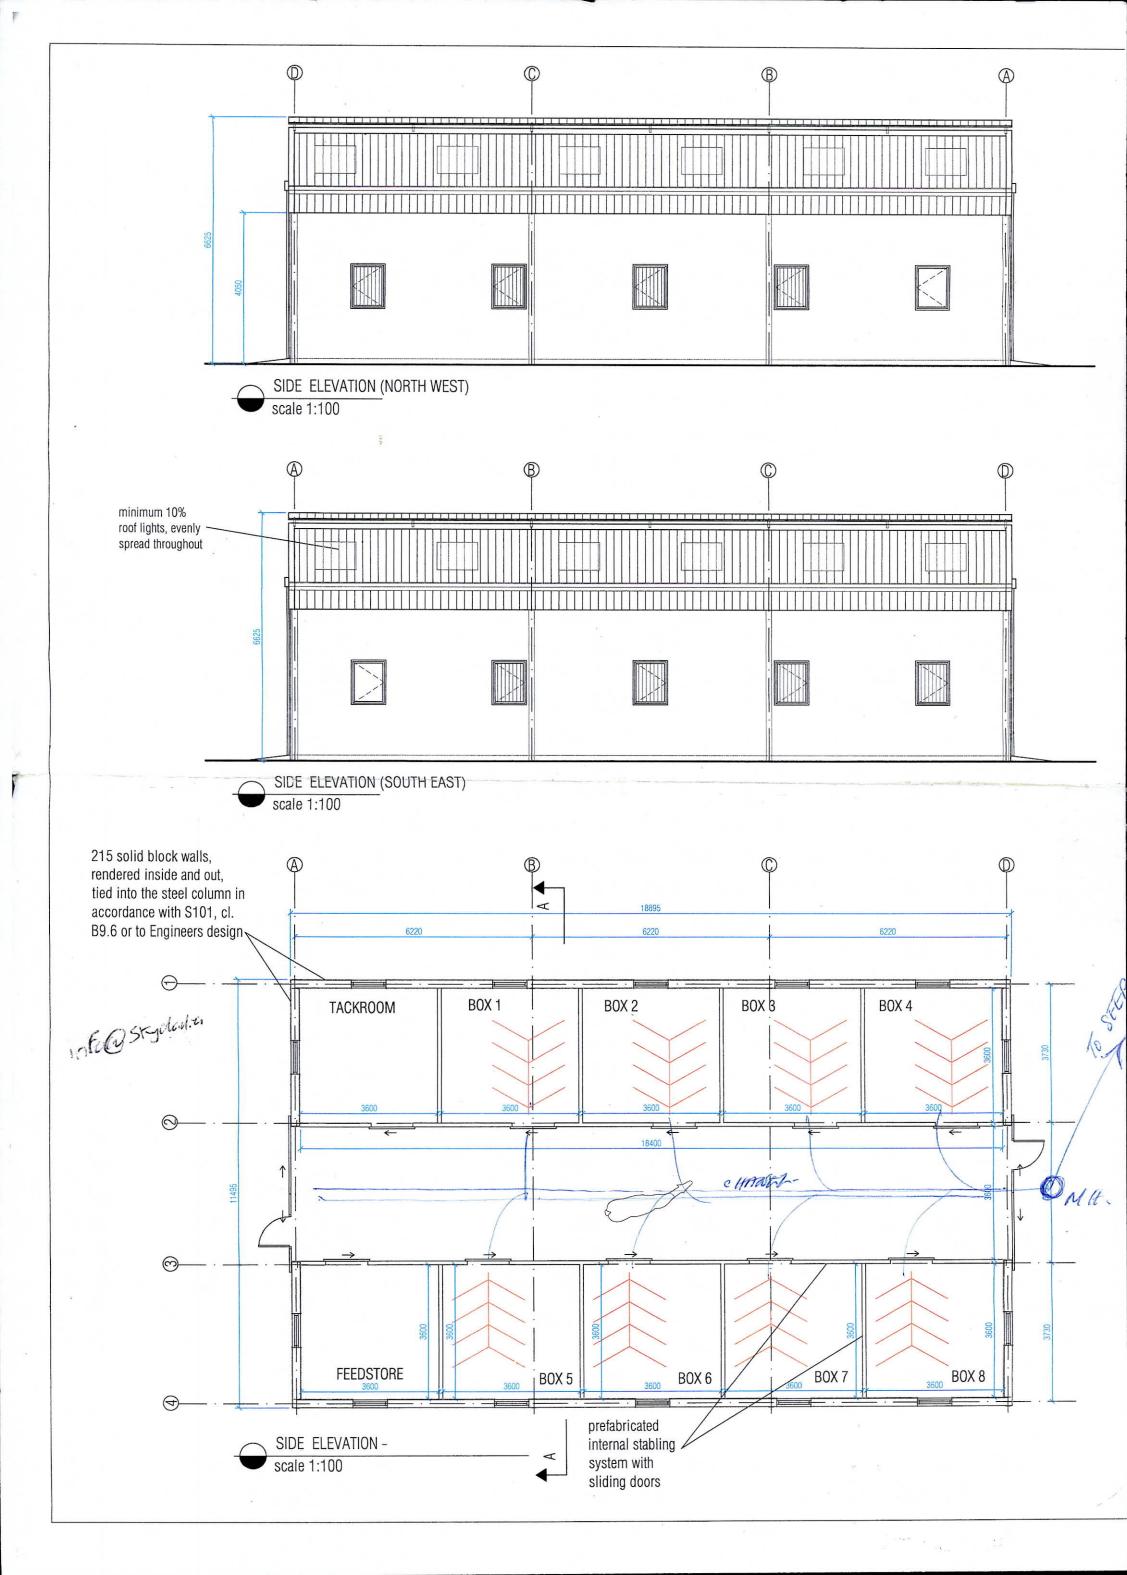

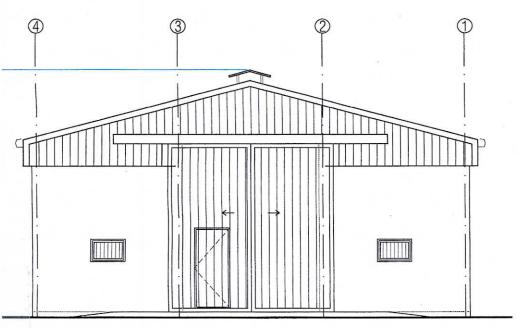


REAR ELEVATION (NORTH EAST)

scale 1:100

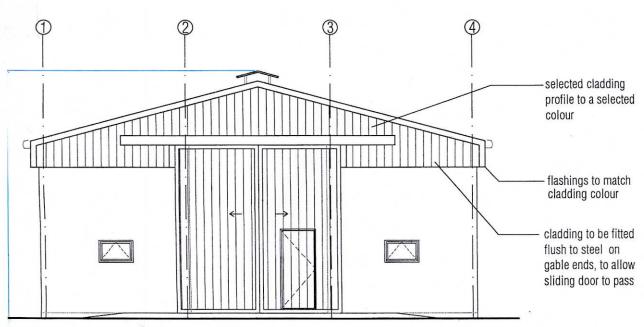

FRONT ELEVATION (SOUTH WEST)
scale 1:100

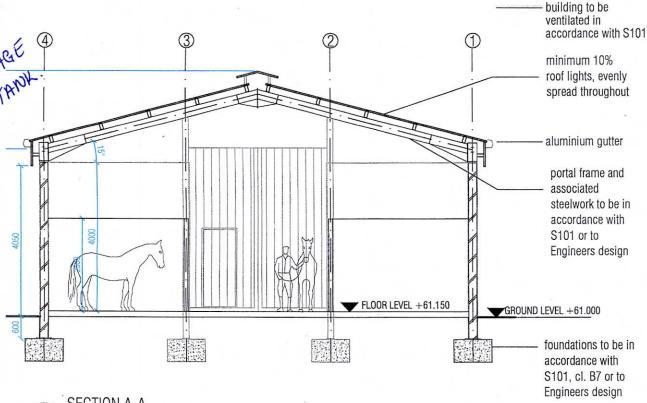

SECTION A-A scale 1:100



TOTAL FLOOR AREA - 200 Sq M FINISHED FLOOR LEVEL - 61.15 GROUND LEVEL - 61.00 ROAD LEVEL - 63.00 General Notes

# PLANNING ISSUE

NOT FOR CONSTRUCTION USE

# DRAWING TO BE USED FOR PLANNING PURPOSES ONLY

No. Revision

Chartered Building Surveyor

11 An Crois
Allenwood Cross
Allenwood
Naas
Co.Kildare
Tel: 045 860284
Fax: 045 860131
E:information@johnjcross.com

....opening doors to successful building

Date

Client:

## Emer Fallon

Project Name & Address

Proposed American type barn comprising 8 no. horse boxes, tack room & feed store, erection of hayshed and covered dung stead and all associated siteworks.

at Ballycurraghan, Maynooth, Co. Kildare.

Drawing Name:

# PROPOSED AMERICAN TYPE BARN WITH 8 NO. HORSE BOXES

Date:	Drawn By:	Sheet:
09-02-2021	NICKY BOYCE	4 OF 5
Scale:	Checked By:	Drawing No:
1:100 @ A2	JJC	P-004